



Notice of Service Interruption/Area Closure
Western University
Facilities Management
Client Services 519-661-3304 (fmhelp@uwo.ca)

Submit by E-mail
 Print Form

Date of Interruption/Closure: Time(s):

Building(s) Affected: #1 #2
 #3 #4

Areas/Rooms Affected Alternate Route/Service:
 Areas served by fan System 101, 102, 103, 104, 113. See attached HVAC drawings.

Service to be interrupted: #1 #2
 #3 #4

Description/Reason for Project:
 Access to valve for compressed air line within asbestos enclosure.
 The electrical shop is scoping out a future conduit run down this corridor - work will be done at a later date TBD
 2 Asbestos enclosures are being built to accommodate this first visual inspection of the ceiling space.

Requester: Date of Request:

Supervising Tradesperson: Unit:

Trade Manager: Unit: Date:

Contractor: Phone #

Coordinator/Project Manager: Phone # Date:

Reviewed by Trade Manager(s)/Shop(s) Affected:

Name: <input type="text" value="Electrical / Mechanical Shop"/>	Date: <input type="text" value="Feb 10, 2017"/>	Name: <input type="text" value="WES Control"/>	Date: <input type="text" value="Feb 10, 2017"/>
---	---	--	---

Signature/Stamp: APPROVED <i>By spepper (spepper@uwo.ca) at 10:08 am, Feb 10, 2017</i>	Signature/Stamp: RECEIVED <i>By Wayne Drummond (ppdwad@uwo.ca) at 10:06 am, Feb 10, 2017</i>
--	--

Name: Date: Principal Occupants:


Name: <input type="text"/>	Ext. <input type="text"/>	Date: <input type="text"/>
Name: <input type="text"/>	Ext. <input type="text"/>	Date: <input type="text"/>
Name: <input type="text"/>	Ext. <input type="text"/>	Date: <input type="text"/>
Name: <input type="text"/>	Ext. <input type="text"/>	Date: <input type="text"/>

Signature/Stamp: Date:

Approval to Proceed: Date:


APPROVED
By Dan Trudgeon (dtrudgeo@uwo.ca) at 3:50 pm, Feb 10, 2017

Notes:

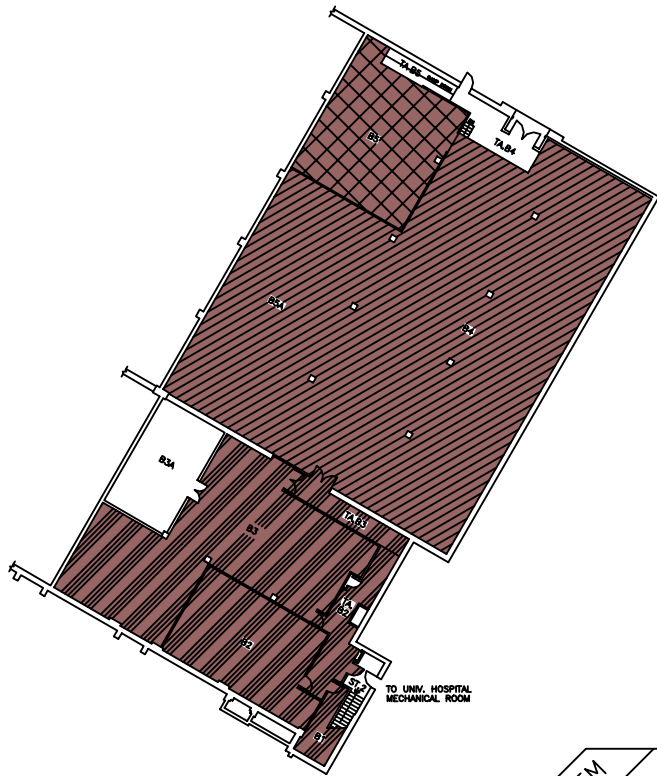

BASEMENT FLOOR

787.88 FT.

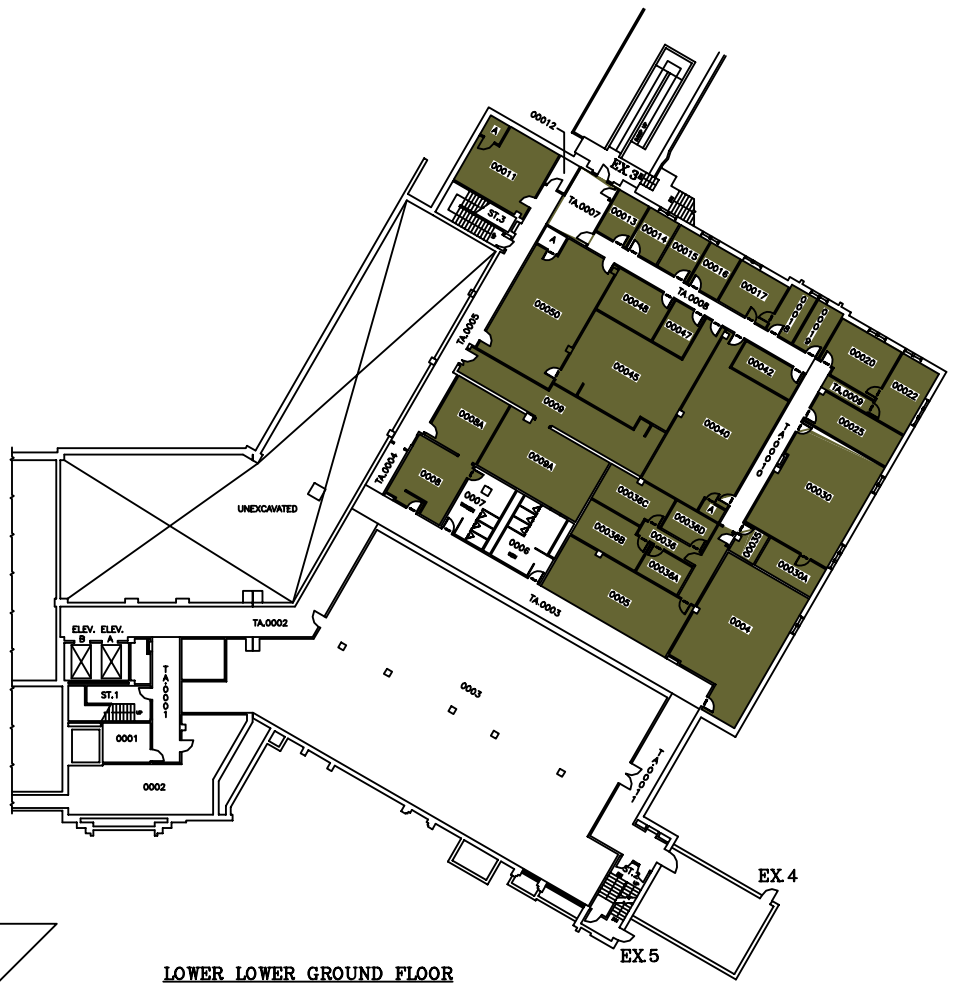

LOWER LOWER GROUND FLOOR

798.89 FT.

SYSTEM	ZONE #
113	A
114	B
	C

**THE UNIVERSITY of WESTERN ONTARIO
PHYSICAL PLANT DEPARTMENT**

	SCALE
	DATE 98-01-28
	DRAWN R. THOMAS
	CHECKED
	APPROVED



Facilities Engineering & Construction

SCALE	1" = 16'
-------	----------

MINIATURE FLOOR PLAN - LEVELS 01 & 02
(BASEMENT & LOWER LOWER GROUND FLOORS)


DENTAL SCIENCES BLDG.

01

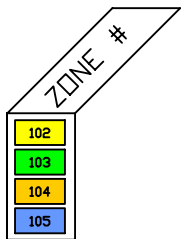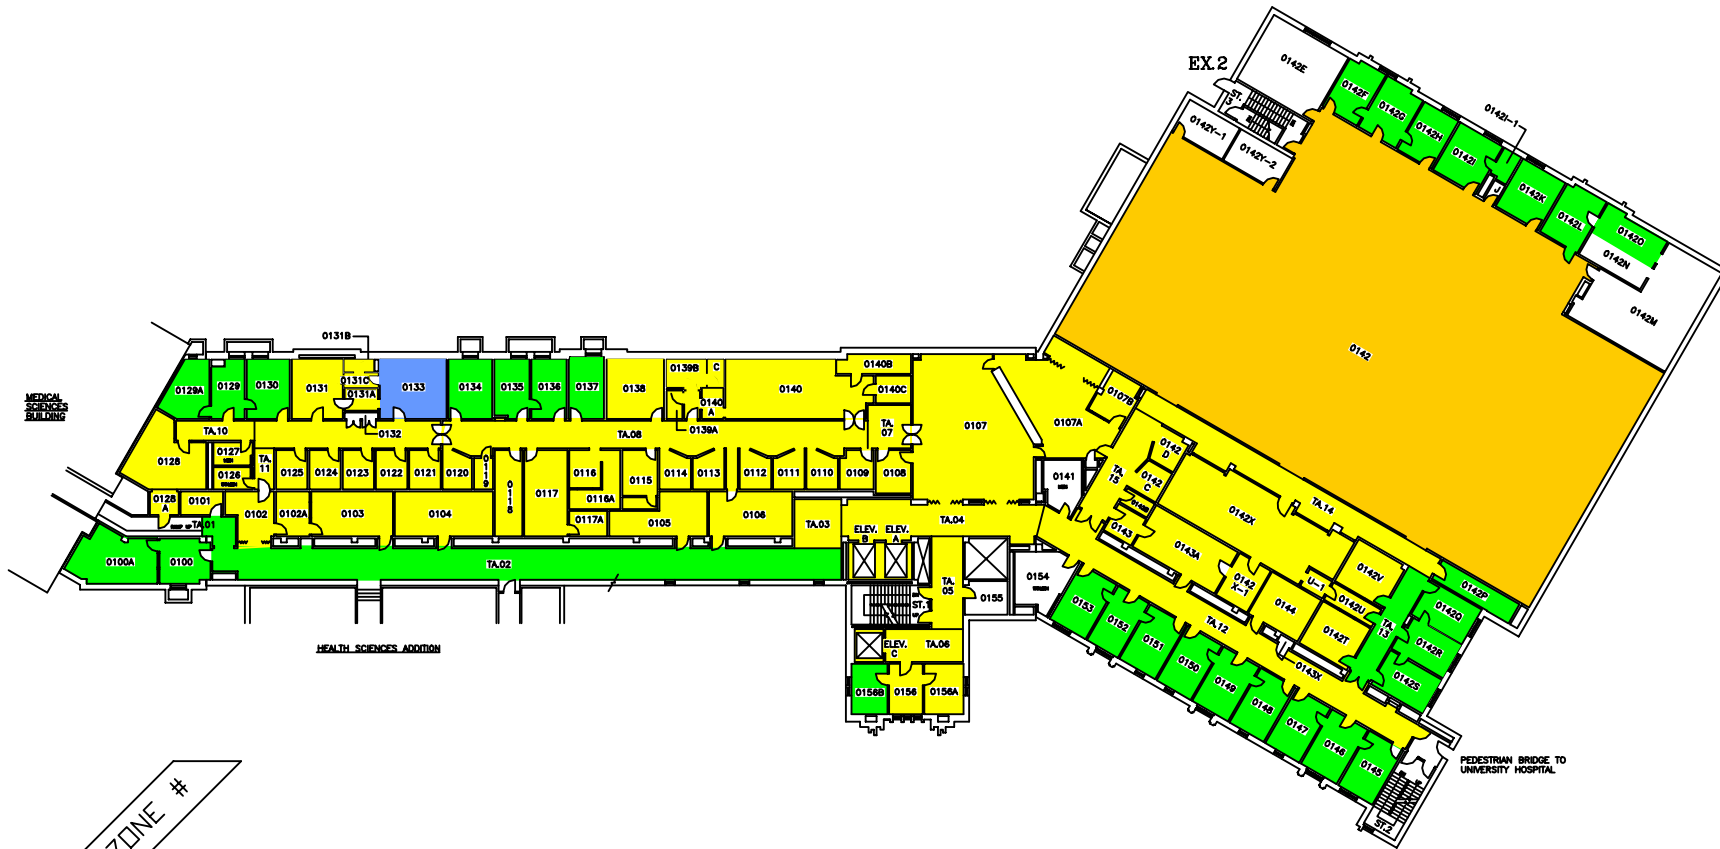


THE UNIVERSITY of WESTERN ONTARIO
PHYSICAL PLANT DEPARTMENT

	SCALE
	DATE 98-01-21
	DRAWN BY R. THOMAS
	CHECKED BY [Signature]
Facilities Engineering & Construction	
SCALE 	GEOMETRIC ELEV. 828.86 FT.
MINATURE FLOOR PLAN - LEVEL 04 (GROUND FLOOR)	
DENTAL SCIENCES BLDG.	
03	

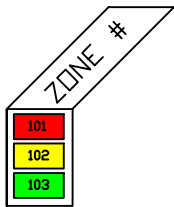

THE UNIVERSITY of WESTERN ONTARIO
PHYSICAL PLANT DEPARTMENT

SCALE
DATE 98-08-08
DRAWN R. THOMAS
CHECKED
APPROVED

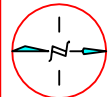

Facilities Engineering & Construction

SCALE 1" = 10' 1/8" 1/4" 1/2" 3/4" 1" 1 1/4" 1 1/2" 2" 3" 4" 6" 8" 10" 12" 15" 20" 30" 40" 50" 60" 80" 100"

MINIATURE FLOOR PLAN - LEVEL 05 (FIRST FLOOR)

DENTAL SCIENCES BLDG.

DSB/MIN

GEOMETRIC ELEV. 840.88 FT.

04



SYSTEM	ZONE #
101	F
102	G
103	H
	I

THE UNIVERSITY of WESTERN ONTARIO
PHYSICAL PLANT DEPARTMENT


	N
	SCALE
	DATE
	DESIGNED BY
	CHECKED BY

Facilities Engineering & Construction


MINIATURE FLOOR PLAN - LEVEL 06
(SECOND FLOOR)

DENTAL SCIENCES BLDG.

05

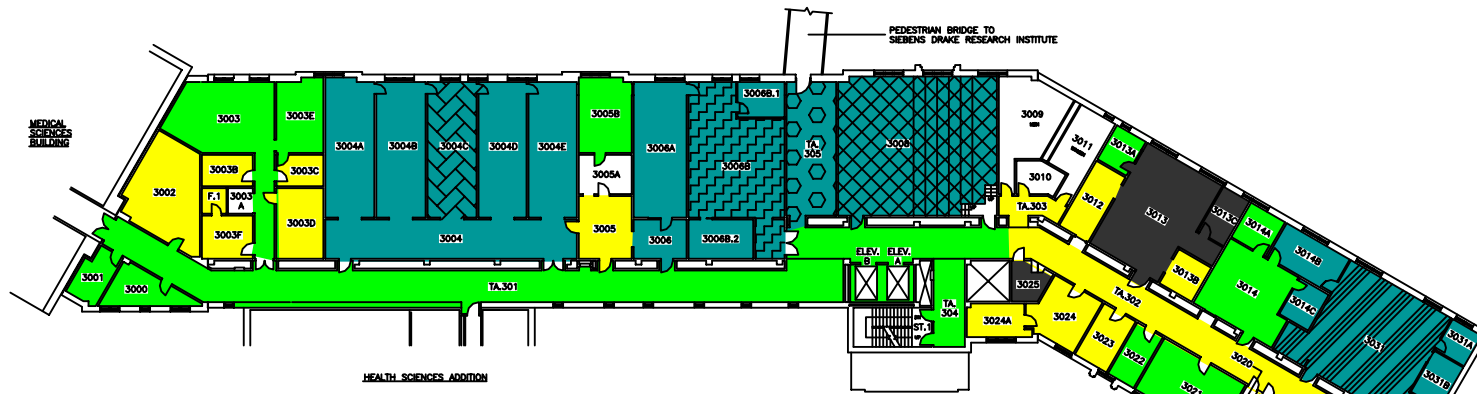


THIRD FLOOR

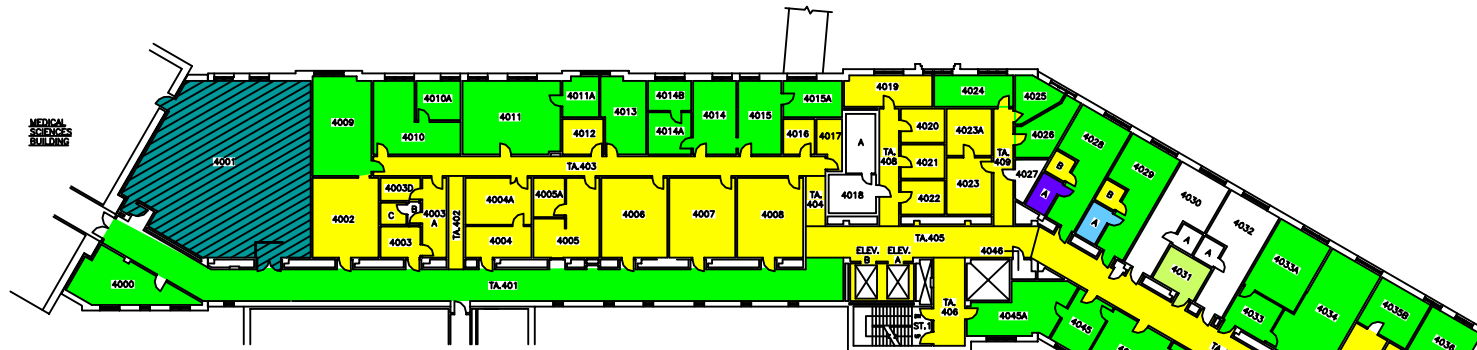

FOURTH FLOOR

SYSTEM	ZONE #
102	A
103	B
107	C
108	D
109	E
110	F
111	

THE UNIVERSITY of WESTERN ONTARIO
PHYSICAL PLANT DEPARTMENT

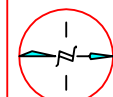


Facilities Engineering & Construction

SCALE 1" = 10' 0" 1:120 1:240 1:480 1:960 1:1920 1:3840


MINIATURE FLOOR PLANS - LEVELS 07 & 08
(3RD AND 4TH FLOORS)

DENTAL SCIENCES BLDG.


SCALE
DATE
98-01-22
DRAWN
R. THOMAS
CHECKED
APPROVED
DWG FILE NO.
DSB/MIN
GEOMETRIC BLVD.
VARIES
SHEET
06

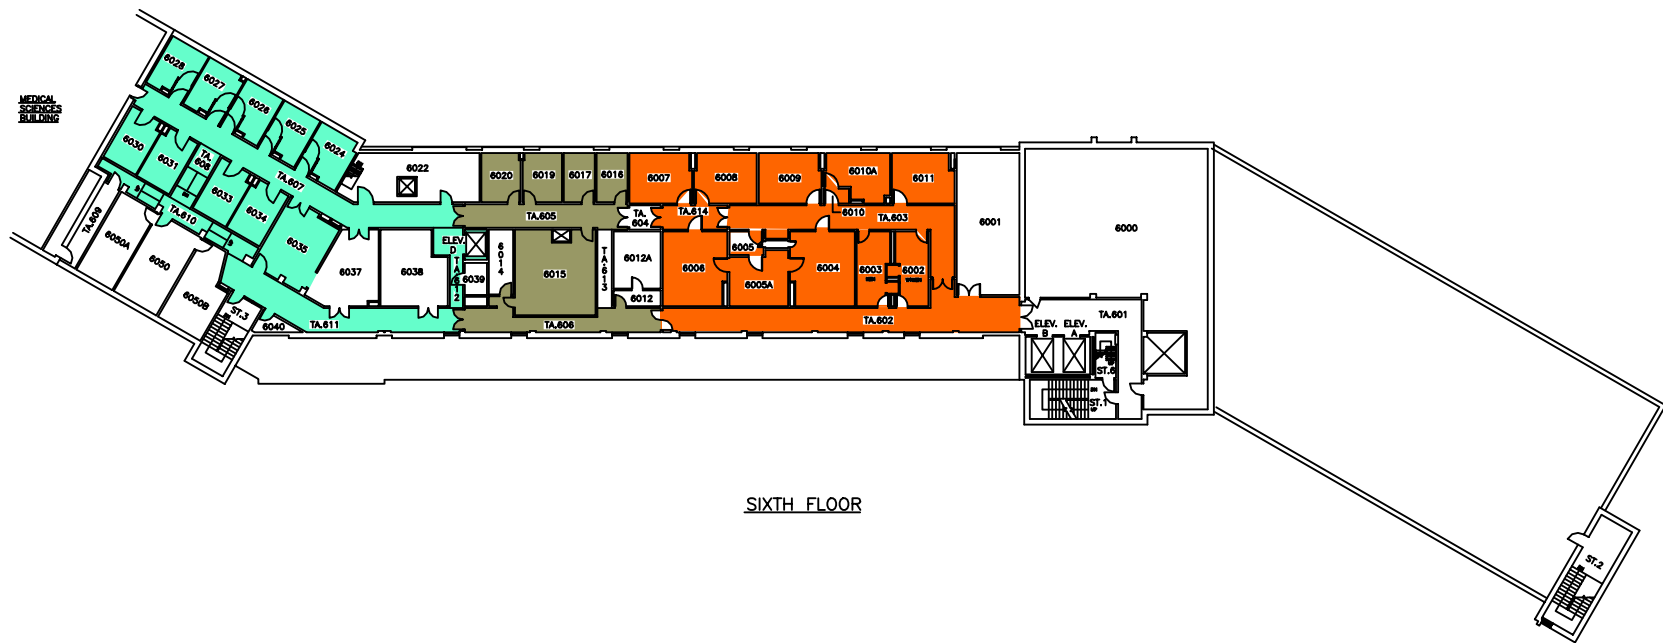


SIXTH FLOOR

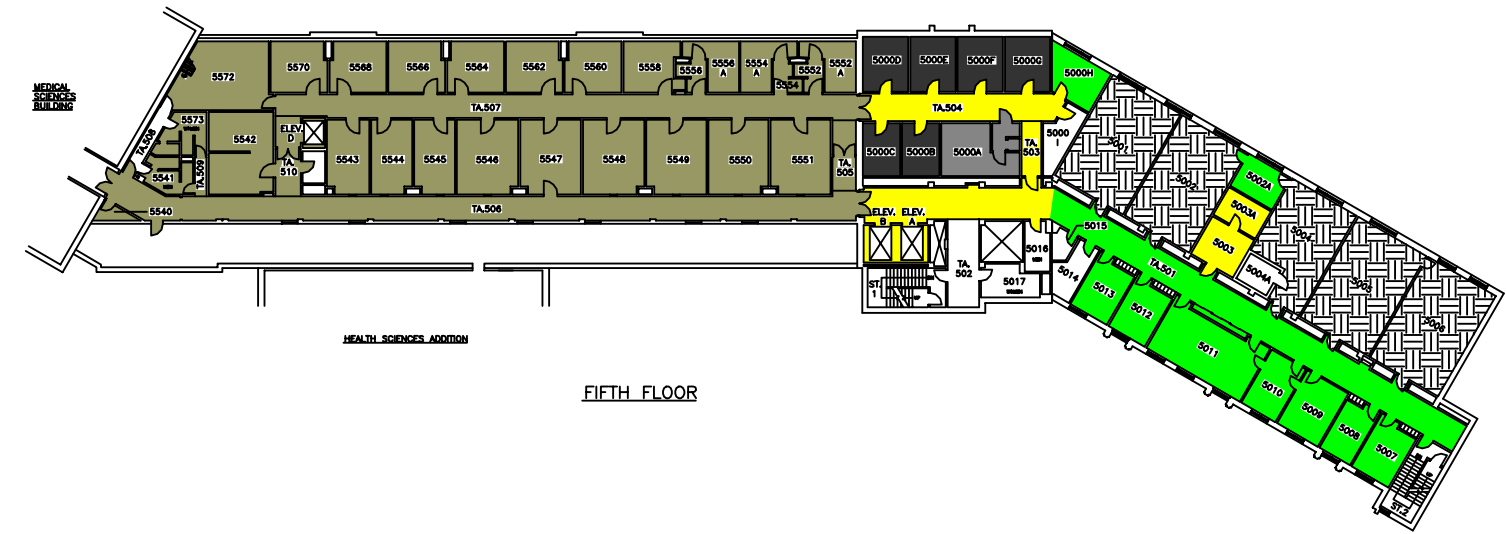

FIFTH FLOOR

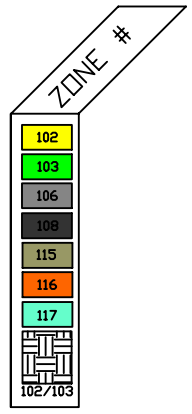

THE UNIVERSITY of WESTERN ONTARIO
PHYSICAL PLANT DEPARTMENT

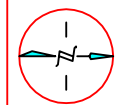

Facilities Engineering & Construction

SCALE 1" = 10' 1/8" 1/4" 1/2" 1" 2" 4" 8"
MINIATURE FLOOR PLANS - LEVELS 09 & 10
(5TH AND 6TH FLOORS)

DENTAL SCIENCES BLDG.

SCALE	1" = 10'
DATE	98-01-21
DESIGNED BY	R. THOMAS
CHECKED BY	
APPROVED BY	
DRAWN BY	DSB/MIN
GEOMETRIC BLEV.	VARIABLES
HEET	07